




SEE EXHIBIT 40.6-1 FOR BURNHAM SOUTH ROAD PLAN AND PROFILE

LEGEND

- BURNHAM SOUTH ROAD
- EAST HAUL ROAD
- SERVICE ROAD & SERVICE ROAD LOOP
- PAVED ROAD
- DIRT ROAD
- TRAIL
- BUILDING
- FENCE
- IRRIGATION LINE
- CULVERT
- LOW SPOT ELEVATION
- DRAINAGE
- RAILROAD
- TREES
- POWERLINE
- x 5338.5 SPOT ELEVATION
- 6306 INDEX CONTOUR
- 218 5422.45 INTERMEDIATE CONTOUR
- + L-30 HORIZ. & VERT. CONTROL
- LEASE CORNER
- LEASE BOUNDARY
- PERMIT BOUNDARY

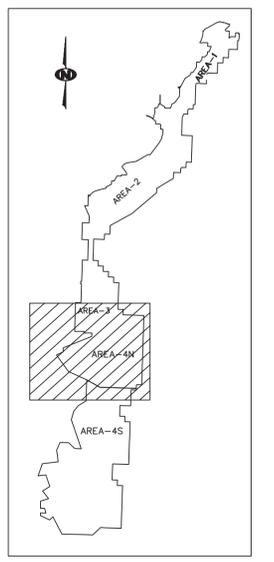


THESE PLANS ILLUSTRATE THE DESIGN OF THE PROPOSED EAST HAUL ROAD AND SERVICE ROAD LOOP AND ASSUME THAT THEY WILL BE CONSTRUCTED CONCURRENTLY WITH THE BURNHAM SOUTH ROAD. SEE EXHIBIT 40.6-1 FOR THE DESIGN OF THE BURNHAM SOUTH ROAD. IF CONSTRUCTION IS NOT PERFORMED CONCURRENTLY PROVIDE TEMPORARY GRADING TO FACILITATE DRAINAGE.



EAST HAUL ROAD
STA 326+00 TO 348+00
SCALE: 1" = 100'

EAST HAUL ROAD LINE AND CURVE TABLE

LINE	LENGTH	BEARING	START NORTHING	START EASTING	END NORTHING	END EASTING	CURVE	LENGTH	RADIUS	DELTA ANGLE	TANGENT	CHORD BEARING	CHORD
L1	290.22'	S 42°49'57" E	2007120.31	301281.31	2006907.48	301478.62	C1	716.29'	1500.00'	27°21'36" Left	355.11'	S 56°30'45" E	709.50'
L2	254.18'	S 70°11'34" E	2006516.01	302070.35	2006429.88	302309.50	C2	863.70'	1000.00'	49°29'10" Right	460.86'	S 45°28'58" E	837.10'
L3	970.75'	S 20°42'24" E	2005842.62	302906.04	2004934.58	303249.28	C3	676.57'	1600.00'	24°13'40" Left	343.42'	S 32°49'14" E	671.54'
L4	624.22'	S 24°51'45" E	2003798.53	304012.07	2003322.16	304274.52	C4	700.64'	2000.00'	20°04'18" Right	353.95'	S 34°53'54" E	697.06'
L5	464.88'	S 68°02'33" E	2002522.33	305021.28	2002348.50	305452.44	C5	1055.08'	1400.00'	43°10'47" Left	554.01'	S 46°27'09" E	1030.29'
L6	776.38'	S 44°46'50" E	2001969.29	306023.45	2001418.21	306570.33	C6	690.19'	1700.00'	23°15'42" Right	349.91'	S 56°24'41" E	685.46'
L7	5743.03'	S 00°00'00" E	1998248.43	307876.19	1992505.40	307876.19	C7	3517.07'	4500.00'	44°46'50" Right	1853.88'	S 22°23'25" E	3428.23'
L8	479.43'	N 89°37'24" W	1991505.42	306869.61	1991508.57	306390.20	C8	1577.37'	1000.00'	90°22'36" Right	1006.60'	S 45°11'18" W	1418.85'

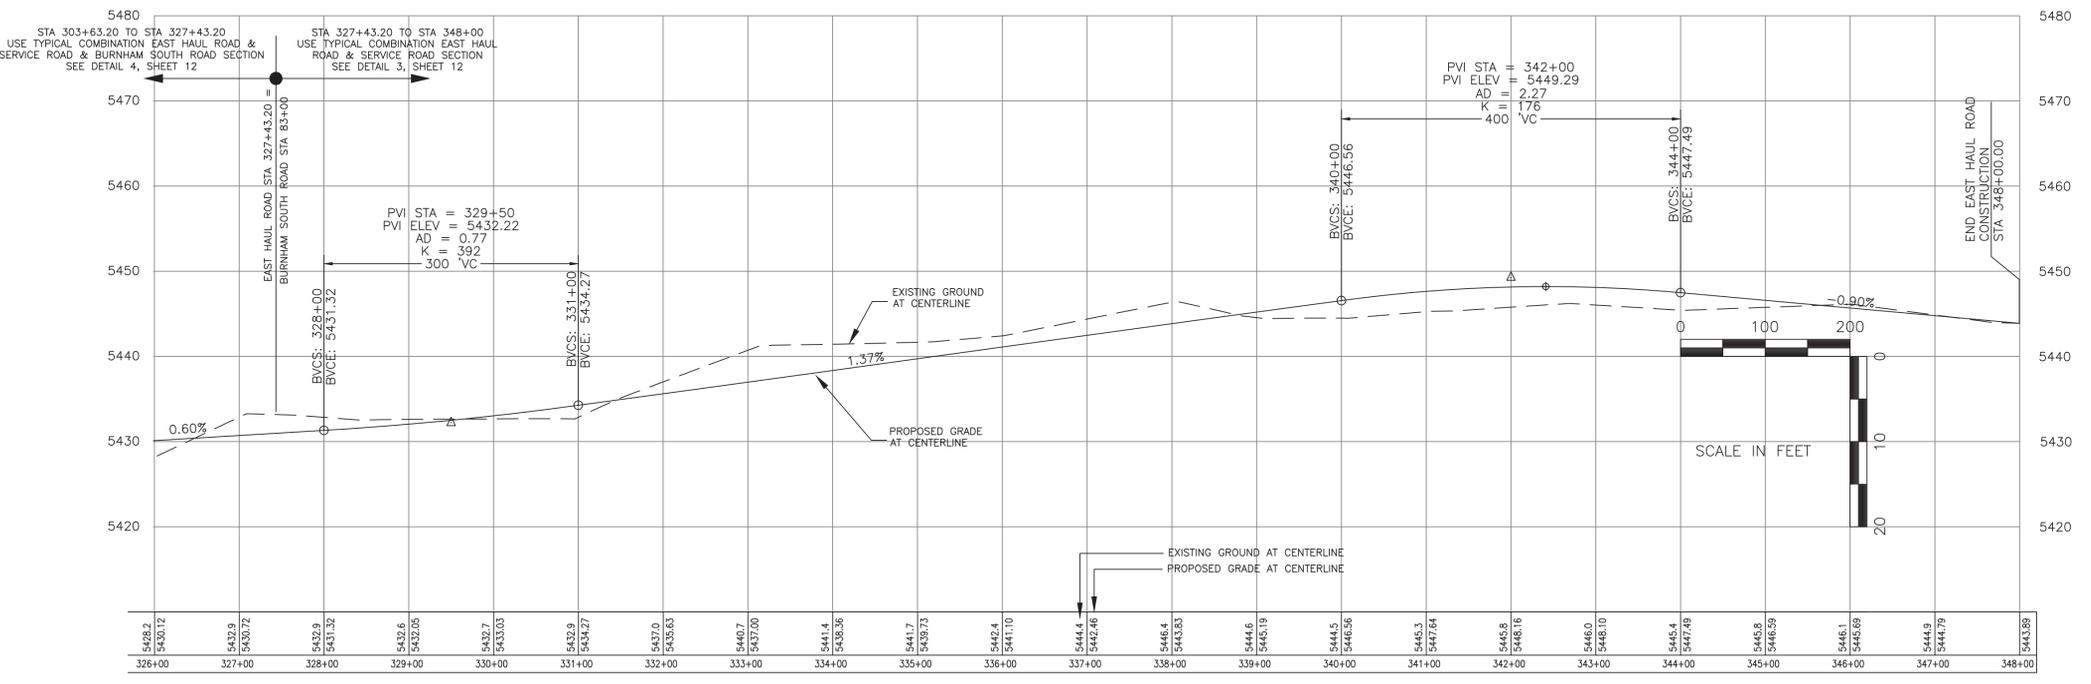

EAST HAUL ROAD
STA 326+00 TO 348+00
1"=100'H 1"=10'V

THE DESIGN FEATURES SHOWN ON THESE DESIGN PLANS ARE REASONABLE REPRESENTATIONS OF THE PROPOSED WORK BASED ON THE INFORMATION AVAILABLE AT THE TIME OF SUBMITTAL OF THIS PERMIT PACKAGE. ACTUAL CONSTRUCTION DETAILS MAY VARY FROM THOSE SHOWN.

NOT ISSUED FOR CONSTRUCTION

CERTIFICATION STATEMENT
I, GEORGE A. MADRID, P.E., HEREBY CERTIFY THAT THIS DRAWING WAS REVIEWED BY ME AND THAT THE INFORMATION SHOWN IS COMPLETE AND ACCURATE TO THE BEST OF MY KNOWLEDGE.



George A. Madrid
INC.
915 Malta Avenue • Farmington, NM 87401 • (505) 327-7928

REV. NO.	DATE	COMMENT
3	05-15-14	REVISED TITLE BLOCK
2	12-17-13	REVISED PER OSM COMMENT
1	03-15-12	REVISED TITLE & TITLE BLOCK
0	02-07-12	INITIAL PERMIT SUBMITTAL

EXHIBIT 23.2-2
NTEC
Navajo Transitional Energy Company, LLC
Navajo Mine
PINABETE PERMIT
PLAN & PROFILE: EAST HAUL ROAD & SERVICE ROAD STA 326+00 TO 348+00
SHEET: 9 OF 13
PREPARED BY: BT&PR DRAWN BY: BT&PR SCALE: AS SHOWN
APPROVED BY: GM DATE: 02-07-2012
GEOMAT PROJECT NO. 112-1434